


EXISTING VERIZON ANTENNA (TYP. OF 2 PER SECTOR, TOTAL OF 6)

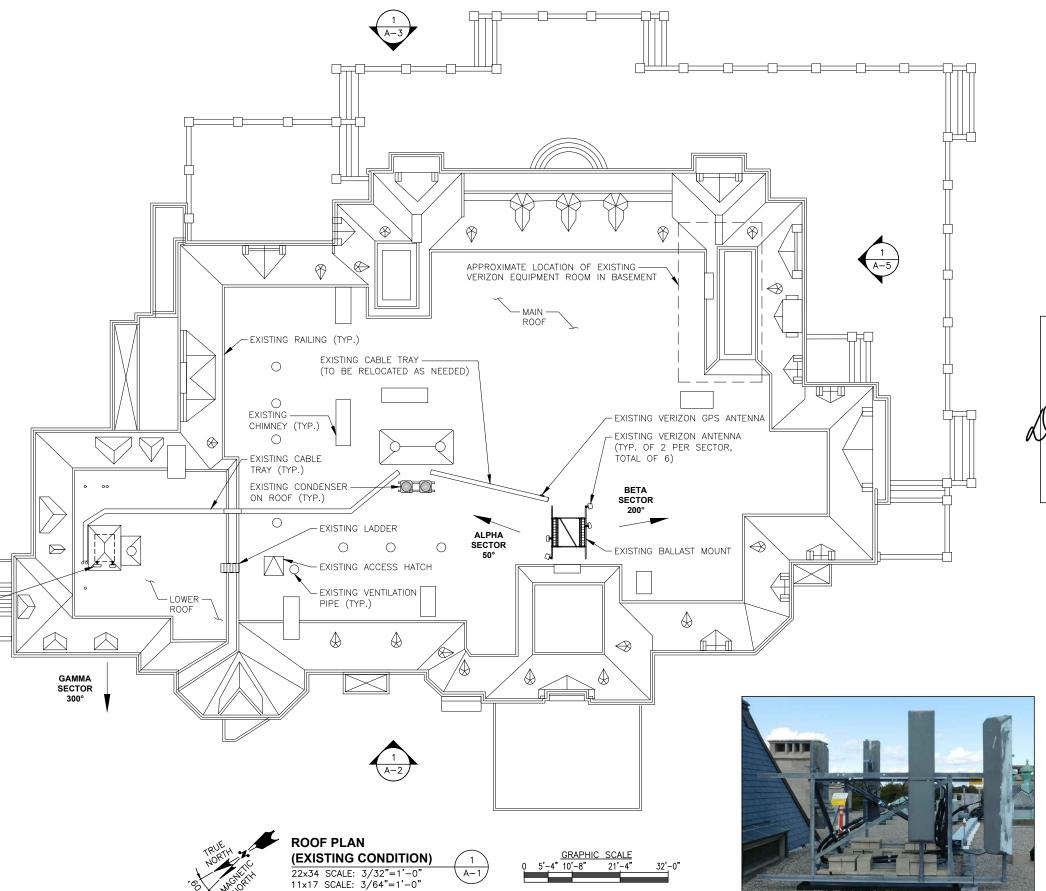

ALPHA SECTOR (EXISTING CONDITION) SCALE: N.T.S





BETA SECTOR (EXISTING CONDITION)

SCALE: N.T.S

 $\begin{pmatrix} 4 \\ A-1 \end{pmatrix}$

verizon



118 FLANDERS ROAD WESTBOROUGH, MA 01581

DANIEL P. HAMM



CHECKED BY:

APPROVED BY:

SUBMITTALS DESCRIPTION 5 02/08/21 REVISED PER COMMENTS 4 01/06/21 ADDED ELEVATIONS 3 11/09/20 MOVED RRH's 2 02/25/20 REVISED PER COMMENTS 1 01/31/20 REVISED PER COMMENTS 0 11/22/19 FOR CONSTRUCTION


NEWPORT SOUTH RI

SITE ADDRESS: 16 OCHRE POINT AVENUE NEWPORT, RI 02840

> SHEET TITLE ROOF PLAN (EXISTING CONDITION)

SHEET NUMBER



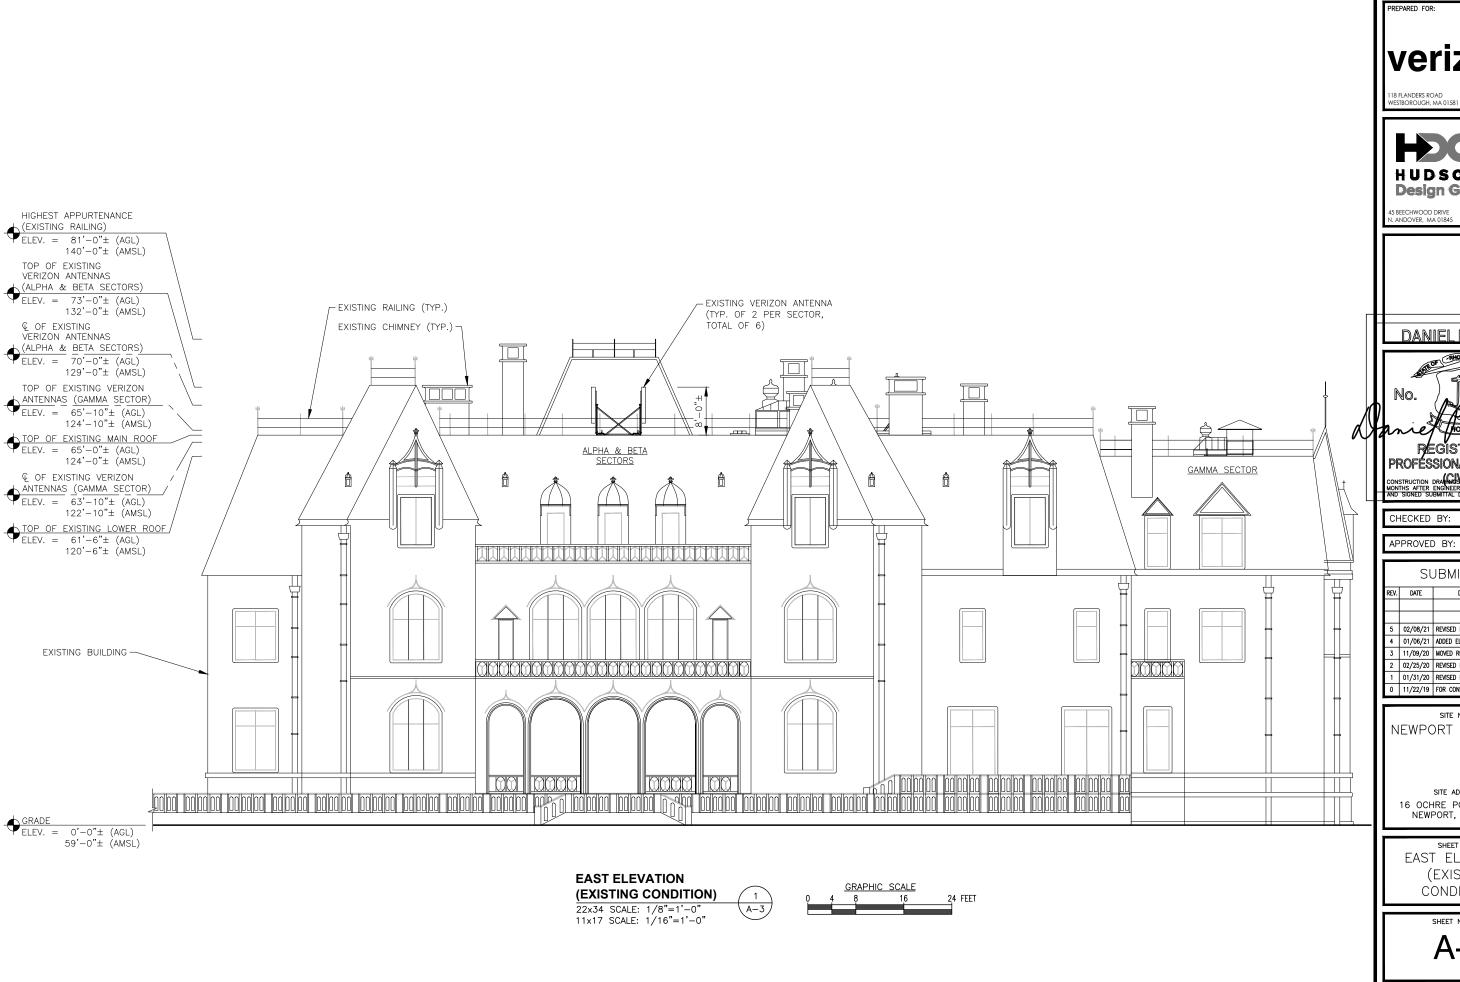

verizon



DANIEL P. HAMM



REGISTERED PROFÉSSIONAL ENGINEER

CONSTRUCTION DRAWNED VALID FOR SIX MONTHS AFTER ENGINEER OF RECORD'S STAMPED AND SIGNED SUBMITTAL DATE LISTED HEREIN

SUBMITTALS

DPH


		30	JUNITTALS	
	REV.	DATE	DESCRIPTION	BY
	5	02/08/21	REVISED PER COMMENTS	0S
	4	01/06/21	ADDED ELEVATIONS	OS
	3	11/09/20	MOVED RRH's	OS
	2	02/25/20	REVISED PER COMMENTS	SF
	1	01/31/20	REVISED PER COMMENTS	OS
	0	11/22/19	FOR CONSTRUCTION	OS.

NEWPORT SOUTH RI

SITE ADDRESS: 16 OCHRE POINT AVENUE NEWPORT, RI 02840

SHEET TITLE EAST ELEVATION (EXISTING CONDITION)

SHEET NUMBER

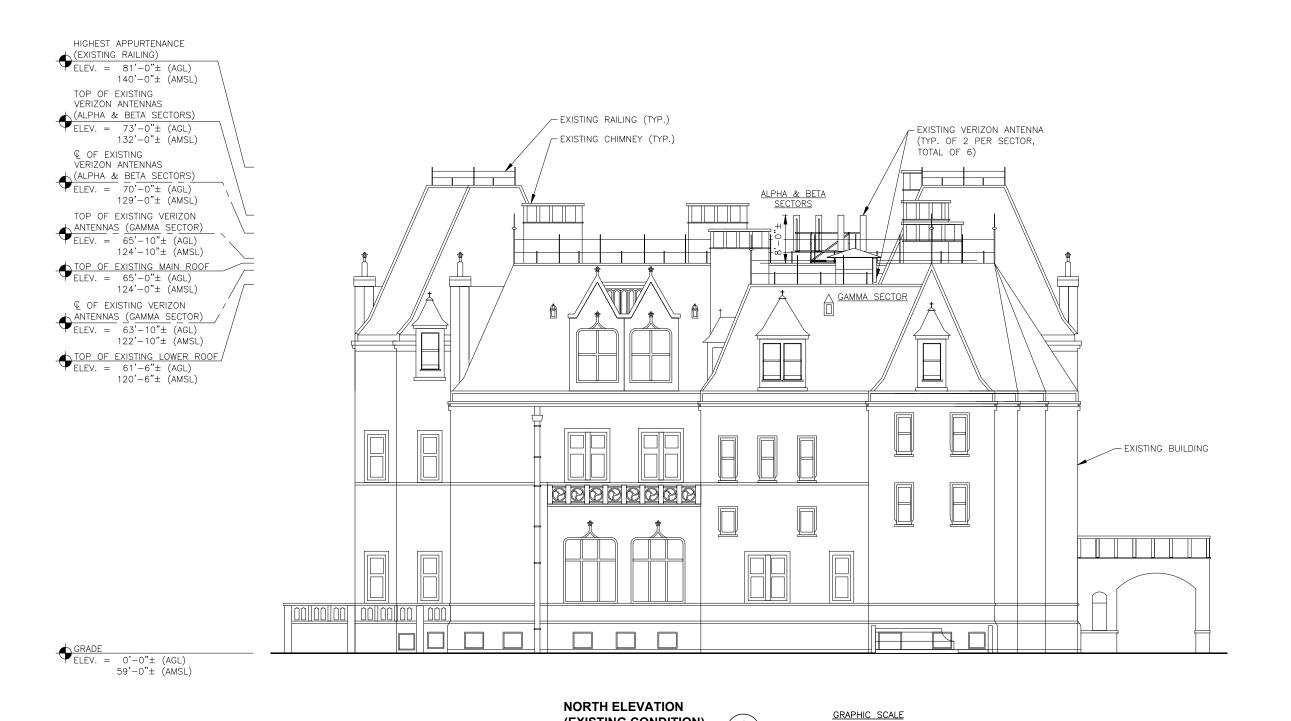

(EXISTING CONDITION)

A-4

22x34 SCALE: 1/8"=1'-0"

11x17 SCALE: 1/16"=1'-0"

24 FEET

PREPARED FOR:

verizon

118 FLANDERS ROAD WESTBOROUGH, MA 01581



CHWOOD DRIVE TEL: (978)

DANIEL P. HAMM



REGISTERED
PROFESSIONAL ENGINEER
CONSTRUCTION DRAGGIVED VALID FOR SIX MONTHS AFTER ENGINEER OF RECORDS STAMPED AND SIGNED SUBMITTAL DIATE LUSTED HEREIN

CHECKED BY:

APPROVED BY:

SUBMITTALS

DPH

	REV.	DATE	DESCRIPTION	BY
	5	02/08/21	REVISED PER COMMENTS	0S
	4	01/06/21	ADDED ELEVATIONS	0S
	3	11/09/20	MOVED RRH's	0S
	2	02/25/20	REVISED PER COMMENTS	SF
	1	01/31/20	REVISED PER COMMENTS	0S
	0	11/22/19	FOR CONSTRUCTION	0S
,				

site name: NEWPORT SOUTH RI

SITE ADDRESS:

16 OCHRE POINT AVENUE
NEWPORT, RI 02840

SHEET TITLE

NORTH ELEVATION

(EXISTING

CONDITION)

SHEET NUMBER



PREPARED FOR:

verizon v

118 FLANDERS ROAD WESTBOROUGH, MA 01581



45 BEECHWOOD DRIVE

DANIEL P. HAMM



REGISTERED
PROFESSIONAL ENGINEER
CONSTRUCTION DRAWNAL FOR SIX MONTHS AFTER ENGHER OF RECORDS STAMPED AND SIGNED SUBMITTAL DATE LISTED FEREIN

CHECKED BY:

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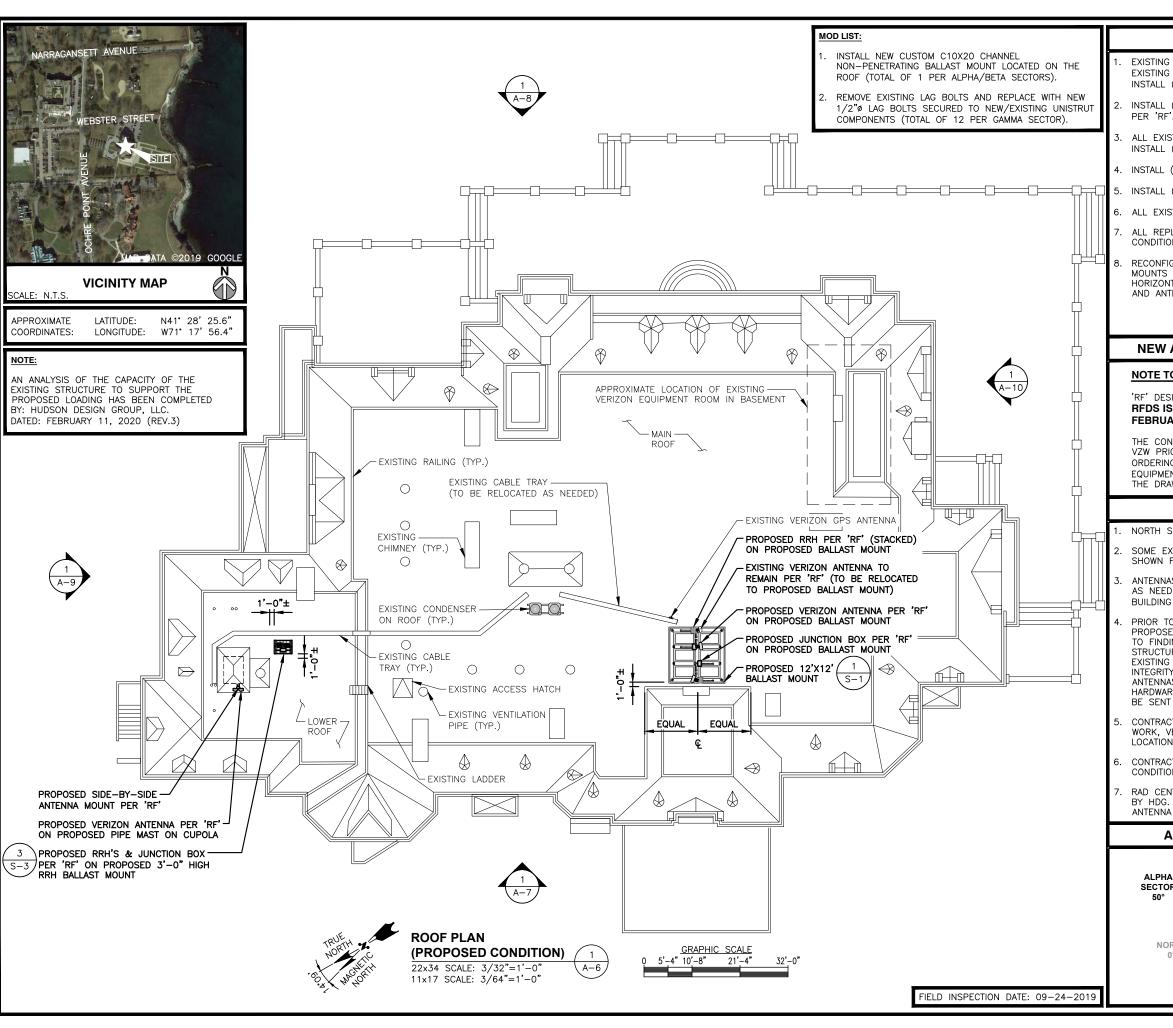
	SUBMITTALS				
REV.	DATE	DESCRIPTION	BY		
5	02/08/21	REVISED PER COMMENTS	0S		
4	01/06/21	ADDED ELEVATIONS	0S		
3	11/09/20	MOVED RRH's	0S		
2	02/25/20	REVISED PER COMMENTS	SF		
1	01/31/20	REVISED PER COMMENTS	0S		
0	11/22/19	FOR CONSTRUCTION	0S		

SITE NAME: NEWPORT SOUTH RI

SITE ADDRESS: 16 OCHRE POINT AVENUE NEWPORT, RI 02840

SHEET TITLE
SOUTH ELEVATION
(EXISTING
CONDITION)

SHEET NUMBER



SCOPE

- EXISTING (5) ANTENNAS TO BE REMOVED, EXISTING (1) ANTENNA TO REMAIN, INSTALL (4) PROPOSED ANTENNAS PER 'RF'.
- INSTALL (1) SIDE-BY-SIDE ANTENNA MOUNT
- ALL EXISTING RRH'S TO BE REMOVED, INSTALL (6) PROPOSED RRH'S PER 'RF'.
- 4. INSTALL (3) PROPOSED JUNCTION BOXES PER 'RF'
- 5. INSTALL (3) PROPOSED HYBRID CABLES PER 'RF'
- 6. ALL EXISTING COAX CABLES TO REMAIN PER 'RF'
- ALL REPLACEMENT ANTENNAS TO MATCH EXISTING CONDITION & HEIGHTS.
- RECONFIGURE/RELOCATE EXISTING ANTENNA MOUNTS AS NECESSARY TO ACCOMMODATE HORIZONTAL SEPARATION, PROPOSED AZIMUTHS, AND ANTENNAS CONFIGURATION.

NEW ANTENNA CONFIGURATION

NOTE TO GENERAL CONTRACTOR:


'RF' DESIGN AND EQUIPMENT IS BASED UPON RFDS ISSUED BY VZW DATED: FEBRUARY 06, 2020 REVISION #6.

THE CONTRACTOR OF RECORD SHALL CONTACT VZW PRIOR TO ANY AND ALL ORDERING/PURCHASING/INSTALLATION OF EQUIPMENT TO VERIFY THAT THE 'RF' LISTED IN THE DRAWING SET IS CURRENT AND UP TO DATE

NOTES

- NORTH SHOWN AS APPROXIMATE.
- SOME EXISTING & PROPOSED INFORMATION NOT SHOWN FOR CLARITY.
- ANTENNAS WILL BE CAMOUFLAGED WITH 3M WRAP. AS NEEDED, PER VERIZON WIRELESS AND BUILDING OWNER'S APPROVAL.
- PRIOR TO COMMENCEMENT OF ANY WORK, PROPOSED ANTENNA INSTALLATION IS PURSUANT TO FINDINGS DICTATED IN STRUCTURAL ANALYSIS. STRUCTURAL ANALYSIS TO VERIFY CAPACITY OF EXISTING STRUCTURE TO ENSURE STRUCTURAL INTEGRITY FOLLOWING INSTALLATION OF PROPOSED ANTENNAS, COAX CABLES AND REQUIRED HARDWARE. COPY OF STRUCTURAL ANALYSIS TO BE SENT TO DESIGN ENGINEER.
- CONTRACTOR SHALL FIFLD VERIFY SCOPE OF WORK, VERIZON WIRELESS ANTENNA MOUNT LOCATION AND ANTENNAS TO BE INSTALLED.
- CONTRACTOR SHALL NOTIFY ENGINEERS IF FIELD CONDITIONS DIFFER FROM DESIGN.
- RAD CENTERS MEASURE IN THE FIELD WITH LASER BY HDG. RAD CENTERS MAY NOT MATCH RF ANTENNA DESIGN SHEET.

ANTENNA ORIENTATION

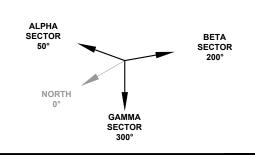

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8 FLANDERS ROAD ESTBOROUGH, MA 01581



DANIEL P. HAMM



PROFÉSSIONAL ENGINEEF

CONSTRUCTION DRAWN THE VALID FOR SIX MONTHS AFTER ENGINEER OF RECORD'S STAMPE AND SIGNED SUBMITTAL DATE LISTED HEREIN

CHECKED BY:

APPROVED BY:

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DPH

REV. DATE DESCRIPTION BY			
REV.	DATE	DESCRIPTION	BY
5	02/08/21	REVISED PER COMMENTS	0S
4	01/06/21	ADDED ELEVATIONS	0S
3	11/09/20	MOVED RRH's	0S
2	02/25/20	REVISED PER COMMENTS	SF
1	01/31/20	REVISED PER COMMENTS	0S
0	11/22/19	FOR CONSTRUCTION	0S

SITE NAME: NEWPORT SOUTH RI

SITE ADDRESS: 16 OCHRE POINT AVENUE NEWPORT, RI 02840

> SHEET TITLE ROOF PLAN (PROPOSED CONDITION)

> > SHEET NUMBER

NOTE:

AN ANALYSIS OF THE CAPACITY OF THE EXISTING STRUCTURE TO SUPPORT THE PROPOSED LOADING HAS BEEN COMPLETED BY: HUDSON DESIGN GROUP, LLC. DATED: FEBRUARY 11, 2020 (REV.3)

HIGHEST APPURTENANCE

PROPOSED ANTENNA INFORMATION

SECTOR	STATUS	AZIMUTH	CABLE LENG
ALPHA	PROPOSED	50°	190'
BETA	PROPOSED/EXISTING	200°	190'
GAMMA	PROPOSED	300°	240'

 $\underline{\text{NOTE:}}$ CABLE LENGTH = EXACT LENGTH PLUS 25'. CONTRACTOR TO VERIFY CABLE LENGTH PRIOR TO ORDERING.



45 BEECHWOOD DRIVE N. ANDOVER, MA 01845

DANIEL P. HAMM



REGISTERED PROFESSIONAL ENGINEER

NSTRUCTION DRA**MMOS ARE,** VALID FOR SIX NTHS AFTER ENGINEER OF RECORD'S STAMPE O SIGNED SUBMITTAL DATE LISTED HEREIN

CHECKED BY:

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APPROVED BY:

SUBMITTALS

DPH

REV.	DATE	DESCRIPTION	BY
5	02/08/21	REVISED PER COMMENTS	0S
4	01/06/21	ADDED ELEVATIONS	0S
3	11/09/20	MOVED RRH's	0S
2	02/25/20	REVISED PER COMMENTS	SF
1	01/31/20	REVISED PER COMMENTS	0S
0	11/22/19	FOR CONSTRUCTION	0S


site name: NEWPORT SOUTH RI

SITE ADDRESS: 16 OCHRE POINT AVENUE NEWPORT, RI 02840

SHEET TITLE
WEST ELEVATION
(PROPOSED
CONDITION)

SHEET NUMBER

A-7

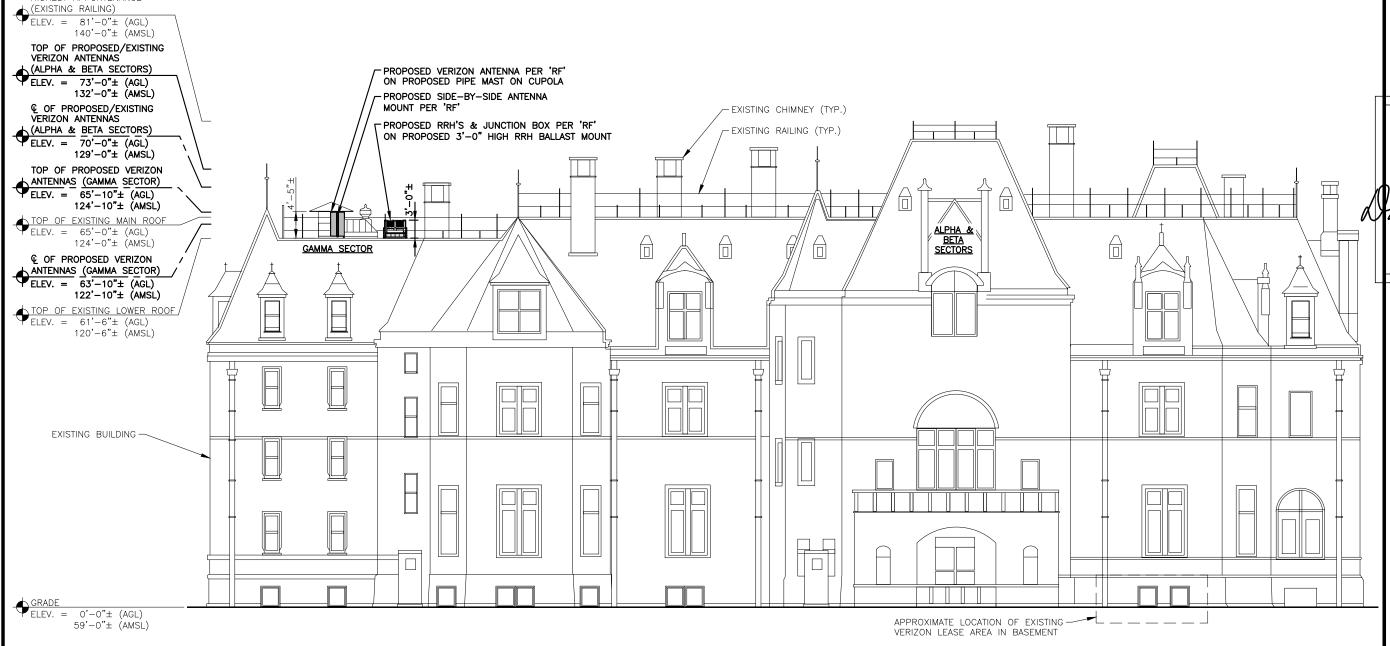

WEST ELEVATION

22x34 SCALE: 1/8"=1'-0"

11x17 SCALE: 1/16"=1'-0"

(PROPOSED CONDITION)

(A-7

24 FEET

AN ANALYSIS OF THE CAPACITY OF THE EXISTING STRUCTURE TO SUPPORT THE PROPOSED LOADING HAS BEEN COMPLETED BY: HUDSON DESIGN GROUP, LLC. DATED: FEBRUARY 11, 2020 (REV.3)

59'-0"± (AMSL)

PROPOSED ANTENNA INFORMATION

SECTOR	STATUS	AZIMUTH	CABLE LENG
ALPHA	PROPOSED	50°	190'
BETA	PROPOSED/EXISTING	200°	190'
GAMMA	PROPOSED	300°	240'

NOTE: CABLE LENGTH = EXACT LENGTH PLUS 25'. CONTRACTOR TO VERIFY CABLE LENGTH PRIOR TO ORDERING. verizon 18 FLANDERS ROAD VESTBOROUGH, MA 01581



DANIEL P. HAMM



PROFÉSSIONAL ENGINEER

DPH

CHECKED BY:

APPROVED BY:

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REV. DATE DESCRIPTION BY			
REV.	DATE	DESCRIPTION	B
5	02/08/21	REVISED PER COMMENTS	0
4	01/06/21	ADDED ELEVATIONS	0
3	11/09/20	MOVED RRH's	0
2	02/25/20	REVISED PER COMMENTS	S
1	01/31/20	REVISED PER COMMENTS	0


NEWPORT SOUTH RI

SITE ADDRESS: 16 OCHRE POINT AVENUE NEWPORT, RI 02840

SHEET TITLE EAST ELEVATION (PROPOSED CONDITION)

SHEET NUMBER

A-8

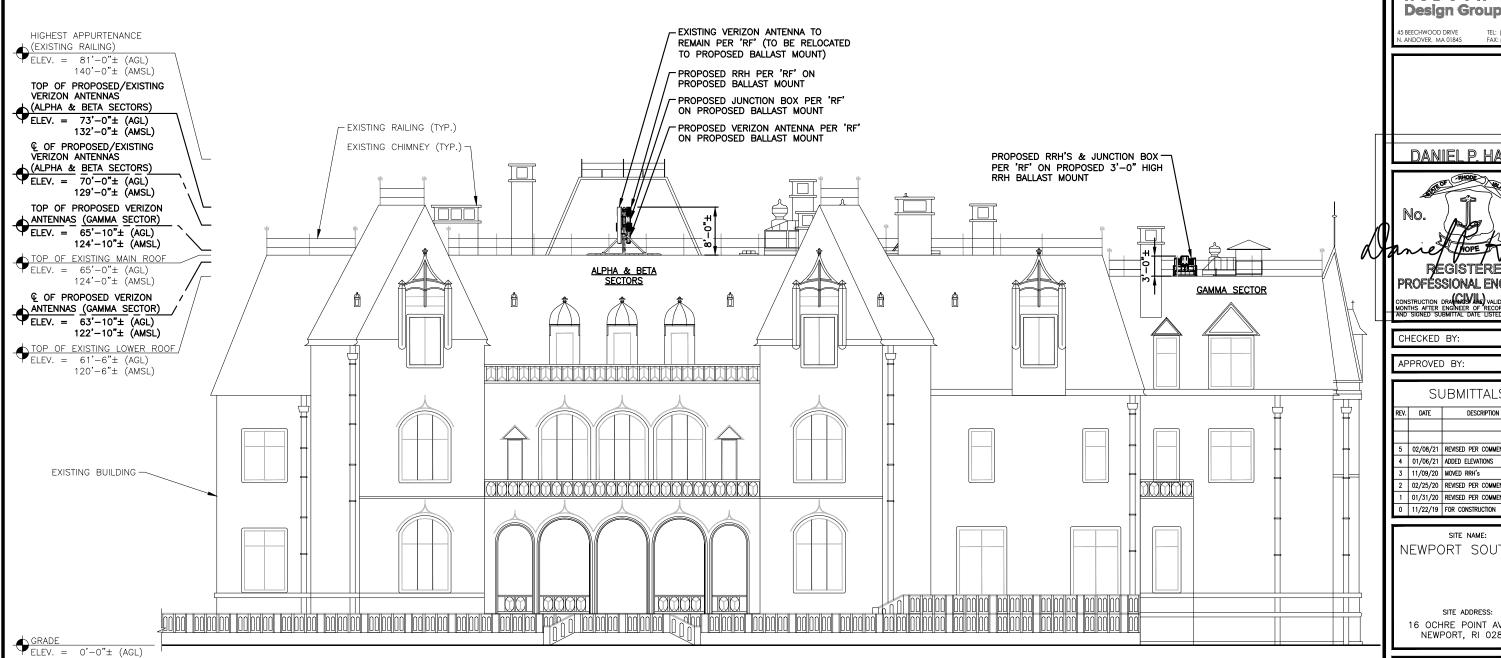

EAST ELEVATION

22x34 SCALE: 1/8"=1'-0"

11x17 SCALE: 1/16"=1'-0"

(PROPOSED CONDITION)

(8-A

24 FEET

AN ANALYSIS OF THE CAPACITY OF THE EXISTING STRUCTURE TO SUPPORT THE PROPOSED LOADING HAS BEEN COMPLETED BY: HUDSON DESIGN GROUP, LLC. DATED: FEBRUARY 11, 2020 (REV.3)

PROPOSED ANTENNA INFORMATION

SECTOR	STATUS	AZIMUTH	CABLE LENGT
ALPHA	PROPOSED	50°	190'
BETA	PROPOSED/EXISTING	200°	190'
GAMMA	PROPOSED	300°	240'

NOTE: CABLE LENGTH = EXACT LENGTH PLUS 25'. CONTRACTOR TO VERIFY CABLE LENGTH PRIOR TO ORDERING.



 $\frac{\text{GRADE}}{\text{ELEV.} = 0'-0"\pm (AGL)}$ 59'-0"± (AMSL)

> NORTH ELEVATION (PROPOSED CONDITION) 22x34 SCALE: 1/8"=1'-0"

11x17 SCALE: 1/16"=1'-0"

A-9/



verizon

18 FLANDERS ROAD VESTBOROUGH, MA 01581



DANIEL P. HAMM



REGISTERED PROFÉSSIONAL ENGINEER

DPH

CHECKED BY:

APPROVED BY:

SUBMITTALS

REV.	DATE	DESCRIPTION	BY
5	02/08/21	REVISED PER COMMENTS	0S
4	01/06/21	ADDED ELEVATIONS	0S
3	11/09/20	MOVED RRH's	0S
2	02/25/20	REVISED PER COMMENTS	SF
1	01/31/20	REVISED PER COMMENTS	0S
0	11/22/19	FOR CONSTRUCTION	0S

NEWPORT SOUTH RI

SITE ADDRESS: 16 OCHRE POINT AVENUE NEWPORT, RI 02840

SHEET TITLE NORTH ELEVATION (PROPOSED CONDITION)

SHEET NUMBER

AN ANALYSIS OF THE CAPACITY OF THE EXISTING STRUCTURE TO SUPPORT THE PROPOSED LOADING HAS BEEN COMPLETED BY: HUDSON DESIGN GROUP, LLC. DATED: FEBRUARY 11, 2020 (REV.3)

PROPOSED ANTENNA INFORMATION

SECTOR	STATUS	AZIMUTH	CABLE LENG
ALPHA	PROPOSED	50°	190'
BETA	PROPOSED/EXISTING	200°	190'
GAMMA	PROPOSED	300°	240'

NOTE: CABLE LENGTH = EXACT LENGTH PLUS 25'.
CONTRACTOR TO VERIFY CABLE LENGTH PRIOR TO ORDERING.



HUDSON **Design Group LLC**

DANIEL P. HAMM

PROFÉSSIONAL ENGINEER

CHECKED BY:

APPROVED BY:

SLIRMITTALS

DPH


	SUDMITTALS				
	REV.	DATE	DESCRIPTION	BY	
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ı	4	01/06/21	ADDED ELEVATIONS	0S	
	3	11/09/20	MOVED RRH's	0S	
	2	02/25/20	REVISED PER COMMENTS	SF	
	-	01/31/20	REVISED PER COMMENTS	0S	
ı	0	11/22/19	FOR CONSTRUCTION	0S	

NEWPORT SOUTH RI

SITE ADDRESS: 16 OCHRE POINT AVENUE NEWPORT, RI 02840

SHEET TITLE SOUTH ELEVATION (PROPOSED CONDITION)

A-10

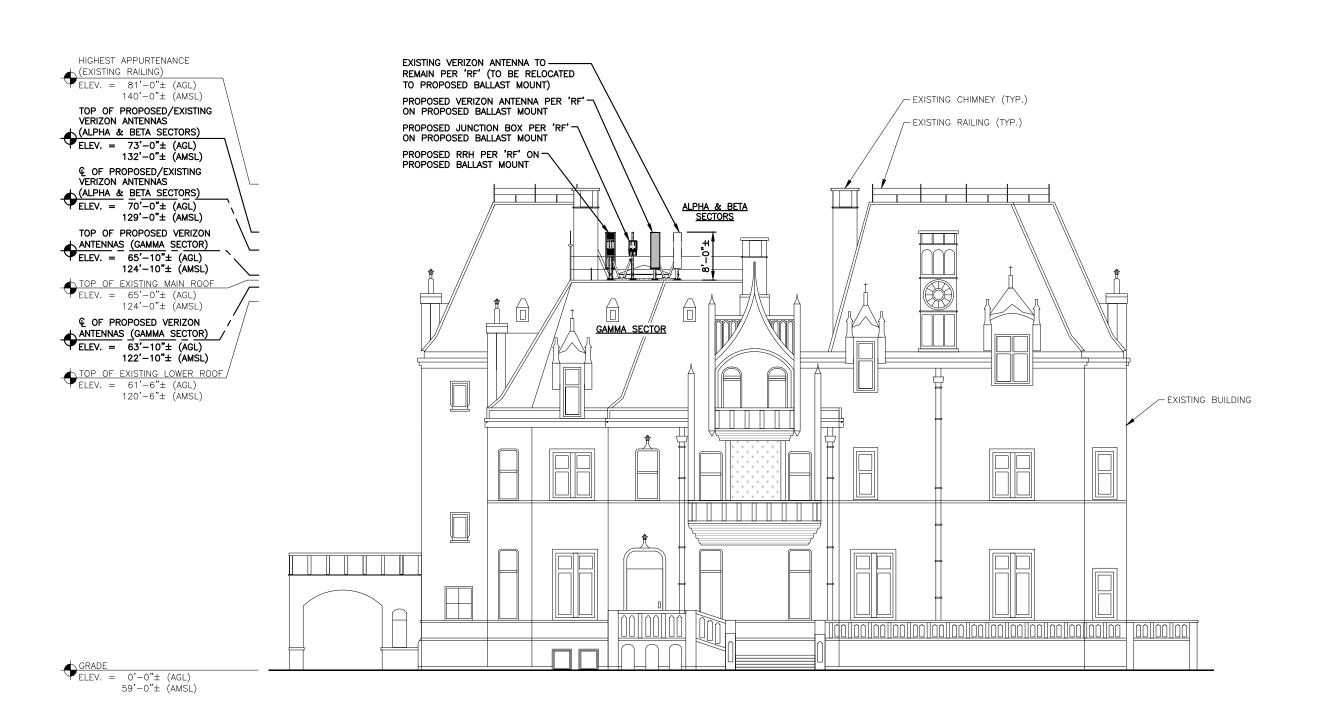

SOUTH ELEVATION

22x34 SCALE: 1/8"=1'-0"

11x17 SCALE: 1/16"=1'-0"


(PROPOSED CONDITION)

A-10

24 FEET



AN ANALYSIS OF THE CAPACITY OF THE EXISTING STRUCTURE TO SUPPORT THE PROPOSED LOADING HAS BEEN COMPLETED BY: HUDSON DESIGN GROUP, LLC. DATED: FEBRUARY 11, 2020 (REV.3)

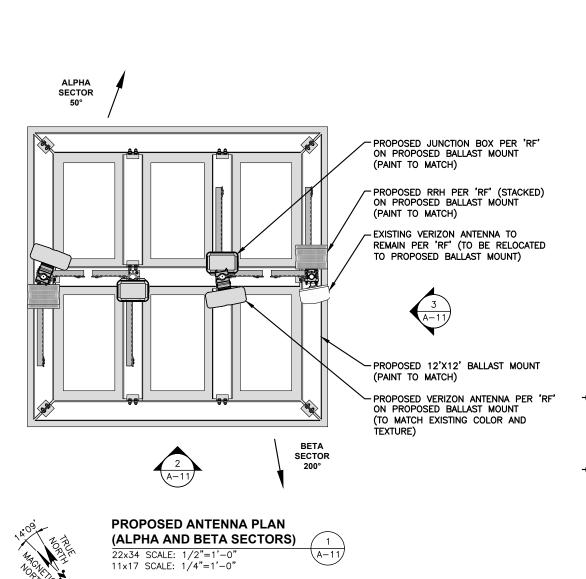

PROPOSED VERIZON ANTENNA PER 'RF' ON PROPOSED BALLAST MOUNT (TO MATCH EXISTING COLOR AND TEXTURE) PROPOSED 12'X12' BALLAST MOUNT -(PAINT TO MATCH) PROPOSED JUNCTION BOX PER 'RF' ON PROPOSED BALLAST MOUNT (PAINT TO MATCH) PROPOSED RRH PER 'RF' ON -PROPOSED BALLAST MOUNT EXISTING VERIZON ANTENNA TO REMAIN PER 'RF' (PAINT TO MATCH) (TO BE RELOCATED TO PROPOSED BALLAST MOUNT) TOP OF PROPOSED/EXISTING VERIZON ANTENNAS (ALPHA & BETA SECTORS) ELEV. = $73'-0"\pm (AGL)$ 132'-0"± (AMSL) © OF PROPOSED/EXISTING VERIZON ANTENNAS (ALPHA & BETA SECTORS) ELEV. = $70'-0"\pm (AGL)$ 129'-0"± (AMSL)

PROPOSED ANTENNA ELEVATION
(ALPHA AND BETA SECTORS)

22x34 SCALE: 1/2"=1'-0"
11x17 SCALE: 1/4"=1'-0"

TO PROPOSED BALLAST MOUNT) PROPOSED JUNCTION BOX PER 'RF' ON PROPOSED BALLAST MOUNT TOP OF PROPOSED/EXISTING VERIZON (PAINT TO MATCH) ANTENNAS (ALPHA & BETA SECTORS)

ELEV. = 73'-0"± (AGL) PROPOSED RRH PER 'RF' ON 132'-0"± (AMSL) PROPOSED BALLAST MOUNT (PAINT TO MATCH) € OF PROPOSED/EXISTING VERIZON ANTENNAS (ALPHA & BETA SECTORS) -PROPOSED VERIZON ANTENNA PER 'RF' ON PROPOSED BALLAST MOUNT ELEV. = 70'-0"± (AGL) 129'-0"± (AMSL) (TO MATCH EXISTING COLOR AND TEXTURE) PROPOSED 12'X12' BALLAST MOUNT (PAINT TO MATCH)



22x34 SCALE: 1/2"=1'-0" 11x17 SCALE: 1/4"=1'-0"



-EXISTING VERIZON ANTENNA TO REMAIN PER 'RF' (TO BE RELOCATED

||verizon

118 FLANDERS ROAD WESTBOROUGH, MA 01581



45 BEECHWOOD DRIVE TEL: (978) 5

DANIEL P. HAMM



REGISTERED PROFESSIONAL ENGINEER

NSTRUCTION DRAMMARS THE VALID FOR SIX NTHS AFTER ENGINEER OF RECORDS STAMPE

CHECKED BY:

APPROVED BY: DPH

> site name: NEWPORT SOUTH RI

0 11/22/19 FOR CONSTRUCTION

SITE ADDRESS: 16 OCHRE POINT AVENUE NEWPORT, RI 02840

SHEET TITLE

PROPOSED ANTENNA PLAN & ELEVATIONS

SHEET NUMBER

STRUCTURAL NOTES:

- DESIGN REQUIREMENTS ARE PER STATE BUILDING CODE AND APPLICABLE SUPPLEMENTS, INTERNATIONAL BUILDING CODE, EIA/TIA-222-G STRUCTURAL STANDARDS FOR STEEL ANTENNA, TOWERS AND ANTENNA SUPPORTING
- CONTRACTOR SHALL VERIFY ALL DIMENSIONS AND CONDITIONS IN THE FIELD PRIOR TO FABRICATION AND ERECTION OF ANY MATERIAL. ANY UNUSUAL CONDITIONS SHALL BE REPORTED TO THE ATTENTION OF THE CONSTRUCTION MANAGER AND ENGINEER OF RECORD.
- DESIGN AND CONSTRUCTION OF STRUCTURAL STEEL SHALL CONFORM TO THE AMERICAN INSTITUTE OF STEEL CONSTRUCTION "SPECIFICATION FOR THE DESIGN FABRICATION AND ERECTION OF STRUCTURAL STEEL FOR BUILDINGS".
- STRUCTURAL STEEL SHALL CONFORM TO ASTM A992 (Fy=50 ksi), MISCELLANEOUS STEEL SHALL CONFORM TO ASTM A36 UNLESS OTHERWISE
- STEEL PIPE SHALL CONFORM TO ASTM A500 "COLD-FORMED WELDED & SEAMLESS CARBON STEEL STRUCTURAL TUBING", GRADE B, OR ASTM A53 PIPE STEEL BLACK AND HOT-DIPPED ZINC-COATED WELDED AND SEAMLESS TYPE E OR S, GRADE B. PIPE SIZES INDICATED ARE NOMINAL. ACTUAL OUTSIDE DIAMETER IS LARGER.
- STRUCTURAL CONNECTION BOLTS SHALL BE HIGH STRENGTH BOLTS (BEARING TYPE) AND CONFORM TO ASTM A325 TYPE-X "HIGH STRENGTH BOLTS FOR STRUCTURAL JOINTS, INCLUDING SUITABLE NUTS AND PLAIN HARDENED WASHERS". ALL BOLTS SHALL BE 3/4" DIA UON.
- ALL STEEL MATERIALS SHALL BE GALVANIZED AFTER FABRICATION IN ACCORDANCE WITH ASTM A123 "ZINC (HOT-DIP GALVANIZED) COATINGS ON IRON AND STEEL PRODUCTS", UNLESS OTHERWISE NOTED.
- ALL BOLTS, ANCHORS AND MISCELLANEOUS HARDWARE SHALL BE GALVANIZED IN ACCORDANCE WITH ASTM A153 "ZINC-COATING (HOT-DIP) ON IRON AND STEEL HARDWARE", UNLESS OTHERWISE NOTED.
- FIELD WELDS, DRILL HOLES, SAW CUTS AND ALL DAMAGED GALVANIZED SURFACES SHALL BE REPAIRED WITH AN ORGANIC ZINC REPAIR PAINT COMPLYING WITH REQUIREMENTS OF ASTM A780. GALVANIZING REPAIR PAINT SHALL HAVE 65 PERCENT ZINC BY WEIGHT, ZIRP BY DUNCAN GALVANIZING, GALVA BRIGHT PREMIUM BY CROWN OR EQUAL. THICKNESS OF APPLIED GALVANIZING REPAIR PAINT SHALL BE NOT NOT LESS THAN 4 COATS (ALLOW TIME TO DRY BETWEEN COATS) WITH A RESULTING COATING THICKNESS REQUIRED BY ASTM A123 OR A153 AS APPLICABLE.
- 10. CONTRACTOR SHALL COMPLY WITH AWS CODE FOR PROCEDURES, APPEARANCE AND QUALITY OF WELDS, AND FOR METHODS USED IN CORRECTING WELDING. ALL WELDERS AND WELDING PROCESSES SHALL BE QUALIFIED IN ACCORDANCE WITH AWS "STANDARD QUALIFICATION PROCEDURES". ALL WELDING SHALL BE DONE USING E70XX ELECTRODES AND WELDING SHALL CONFORM TO AISC AND DI.I. WHERE FILLET WELD SIZES ARE NOT SHOWN. PROVIDE THE MINIMUM SIZE PER TABLE J2.4 IN THE AISC "STEEL CONSTRUCTION MANUAL". 14TH EDITION.
- INCORRECTLY FABRICATED, DAMAGED OR OTHERWISE MISFITTING OR NON-CONFORMING MATERIALS OR CONDITIONS SHALL BE REPORTED TO THE CONSTRUCTION MANAGER PRIOR TO REMEDIAL OR CORRECTIVE ACTION. ANY SUCH ACTION SHALL REQUIRE CONSTRUCTION MANAGER APPROVAL.
- 12. UNISTRUT SHALL BE FORMED STEEL CHANNEL STRUT FRAMING AS MANUFACTURED BY UNISTRUT CORP., WAYNE, MI OR EQUAL. STRUT MEMBERS SHALL BE 1 5/8"x1 5/8"x12GA, UNLESS OTHERWISE NOTED, AND SHALL BE HOT-DIP GALVANIZED AFTER FABRICATION.
- 13. EPOXY ANCHOR ASSEMBLY SHALL CONSIST OF STAINLESS STEEL ANCHOR ROD WITH NUTS & WASHERS. AN INTERNALLY THREADED INSERT, A SCREEN TUBE AND A EPOXY ADHESIVE. THE ANCHORING SYSTEM SHALL BE THE HILTI-HIT HY-270 AND OR HY-200 SYSTEMS (AS SPECIFIED IN DWG.) OR ENGINEERS APPROVED EQUAL
- 14. EXPANSION BOLTS SHALL CONFORM TO FEDERAL SPECIFICATION FF-S-325, GROUP II, TYPE 4, CLASS I, HILTI KWIK BOLT III OR APPROVED EQUAL. INSTALLATION SHALL BE IN ACCORDANCE WITH THE MANUFACTURER'S RECOMMENDATIONS.
- 15. LUMBER SHALL COMPLY WITH THE REQUIREMENTS OF THE AMERICAN INSTITUTE OF TIMBER CONSTRUCTION AND THE NATIONAL FOREST PRODUCTS ASSOCIATION'S NATIONAL DESIGN SPECIFICATION FOR WOOD CONSTRUCTION. ALL LUMBER SHALL BE PRESSURE TREATED AND SHALL BE STRUCTURAL GRADE NO. 2 OR BETTER.
- 6. WHERE ROOF PENETRATIONS ARE REQUIRED, THE CONTRACTOR SHALL CONTACT AND COORDINATE RELATED WORK WITH THE BUILDING OWNER AND THE EXISTING ROOF INSTALLER. WORK SHALL BE PERFORMED IN SUCH A MANNER AS TO NOT VOID THE EXISTING ROOF WARRANTY. ROOF SHALL BE WATERTIGHT
- ALL FIBERGLASS MEMBERS USED ARE AS MANUFACTURED BY STRONGWELL COMPANY OF BRISTOL, VA 24203. ALL DESIGN CRITERIA FOR THESE MEMBERS IS BASED ON INFORMATION PROVIDED IN THE DESIGN MANUAL. ALL REQUIREMENTS PUBLISHED IN SAID MANUAL MUST BE STRICTLY ADHERED TO.
- 18. NO MATERIALS TO BE ORDERED AND NO WORK TO BE COMPLETED UNTIL SHOP DRAWINGS HAVE BEEN REVIEWED AND APPROVED IN WRITING
- 19. SUBCONTRACTOR SHALL FIREPROOF ALL STEEL TO PRE-EXISTING CONDITIONS.

SPECIAL INSPECTIONS (REFERENCE IBC CHAPTER 17):

GENERAL: WHERE APPLICATION IS MADE FOR CONSTRUCTION. THE OWNER OR THE REGISTERED DESIGN PROFESSIONAL IN RESPONSIBLE CHARGE ACTING AS THE OWNER'S AGENT SHALL EMPLOY ONE OR MORE APPROVED AGENCIES TO PERFORM INSPECTIONS DURING CONSTRUCTION ON THE TYPES OF WORK LISTED IN THE INSPECTION CHECKLIST ABOVE.

THE REGISTERED DESIGN PROFESSIONAL IN RESPONSIBLE CHARGE AND ENGINEERS OF RECORD INVOLVED IN THE DESIGN OF THE PROJECT ARE PERMITTED TO ACT AS THE APPROVED AGENCY AND THEIR PERSONNEL ARE PERMITTED TO ACT AS THE SPECIAL INSPECTOR FOR THE WORK DESIGNED BY THEM, PROVIDED THOSE PERSONNEL MEET THE QUALIFICATION REQUIREMENTS.

STATEMENT OF SPECIAL INSPECTIONS: THE APPLICANT SHALL SUBMIT A STATEMENT OF SPECIAL INSPECTIONS PREPARED BY THE REGISTERED DESIGN PROFESSIONAL IN RESPONSIBLE CHARGE IN ACCORDANCE WITH SECTION 107.1 AS A CONDITION FOR ISSUANCE. THIS STATEMENT SHALL BE IN ACCORDANCE WITH SECTION 1705.

REPORT REQUIREMENT: SPECIAL INSPECTORS SHALL KEEP RECORDS OF INSPECTIONS. THE SPECIAL INSPECTOR SHALL FURNISH INSPECTION REPORTS TO THE BUILDING OFFICIAL, AND TO THE REGISTERED DESIGN PROFESSIONAL IN RESPONSIBLE CHARGE REPORTS SHALL INDICATE THAT WORK INSPECTED WAS OR WAS NOT COMPLETED IN CONFORMANCE TO APPROVED CONSTRUCTION DOCUMENTS. DISCREPANCIES SHALL BE BROUGHT TO THE IMMEDIATE ATTENTION OF THE CONTRACTOR FOR CORRECTION. IF THEY ARE NOT CORRECTED, THE DISCREPANCIES SHALL BE BROUGHT TO THE ATTENTION OF THE BUILDING OFFICIAL AND TO THE REGISTERED DESIGN PROFESSIONAL IN RESPONSIBLE CHARGE. A FINAL REPORT DOCUMENTING REQUIRED SPECIAL INSPECTIONS SHALL BE SUBMITTED.

SPECIAL INSPE	SPECIAL INSPECTION CHECKLIST		
BEFORE CO	ONSTRUCTION		
CONSTRUCTION/INSTALLATION INSPECTIONS AND TESTING REQUIRED (COMPLETED BY ENGINEER OF RECORD)	REPORT ITEM		
REQUIRED	ENGINEER OF RECORD APPROVED SHOP DRAWINGS ¹		
REQUIRED	MATERIAL SPECIFICATIONS REPORT		
N/A	FABRICATOR NDE INSPECTION		
REQUIRED	PACKING SLIPS ³		
ADDITIONAL TESTING AND INSPI	ECTIONS:		
DURING CONSTRUCTION			
CONSTRUCTION/INSTALLATION INSPECTIONS AND TESTING REQUIRED (COMPLETED BY ENGINEER OF RECORD)	REPORT ITEM		
REQUIRED	STEEL INSPECTIONS		
N/A	HIGH STRENGTH BOLT INSPECTIONS		
N/A	HIGH WIND ZONE INSPECTIONS '		
N/A	FOUNDATION INSPECTIONS		
N/A	CONCRETE COMP. STRENGTH, SLUMP TESTS AND PLACEMENT		
N/A	POST INSTALLED ANCHOR VERIFICATION ⁵		
N/A	GROUT VERIFICATION		
N/A	CERTIFIED WELD INSPECTION		
N/A	EARTHWORK: LIFT AND DENSITY		
N/A	ON SITE COLD GALVANIZING VERIFICATION		
N/A	GUY WIRE TENSION REPORT		
ADDITIONAL TESTING AND INSPI	ECTIONS:		
AFTER CONSTRUCTION			
CONSTRUCTION/INSTALLATION INSPECTIONS AND TESTING REQUIRED (COMPLETED BY ENGINEER OF RECORD)	REPORT ITEM		
REQUIRED	MODIFICATION INSPECTOR REDLINE OR RECORD DRAWINGS ⁶		
N/A	POST INSTALLED ANCHOR PULL-OUT TESTING		
	PHOTOGRAPHS		

NOTES:

- 1. REQUIRED FOR ANY <u>NEW</u> SHOP FABRICATED FRP OR STEEL.
 2. PROVIDED BY MANUFACTURER, REQUIRED IF HIGH STRENGTH BOLTS OR STEEL.
- 110MPH INSPECT FRAMING OF WALLS, ANCHORING
- ADHESIVE FOR REBAR AND ANCHORS SHALL HAVE BEEN TESTED IN ACCORDANCE WITH ACI 355.4 AND ICC-ES AC308 FOR CRACKED CONCRETE AND SEISMIC APPLICATIONS. DESIGN ADHESIVE BOND STRENGTH HAS BEEN BASED ON ACI 355.4 TEMPERATURE CATEGORY B WITH INSTALLATIONS INTO DRY HOLES DRILLED USING A CARBIDE BIT INTO CRACKED CONCRETE THAT HAS CURED FOR AT LEAST 21 DAYS, ADHESIVE ANCHORS REQUIRING CERTIFIED INSTALLATIONS SHALL BE INSTALLED BY A CERTIFIED ADHESIVE ANCHOR INSTALLER PER ACI 318-11 D.9.2.2. INSTALLATIONS REQUIRING CERTIFIED INSTALLERS. SHALL BE INSPECTED PER ACI 318-11 D.8.2.4.
- AS REQUIRED; FOR ANY FIELD CHANGES TO THE ITEMS IN THIS TABLE.

NOTES:

- ALL CONNECTIONS TO BE SHOP WELDED & FIELD BOLTED USING 3/4" A325-X BOLTS, UNLESS OTHERWISE NOTIFIED
- 2. SHOP DRAWING ENGINEER REVIEW & APPROVAL REQUIRED BEFORE ORDERING MATERIAL.
- SHOP DRAWING ENGINEER REVIEW & APPROVAL REQUIRED PRIOR TO STEEL FABRICATION.
- VERIFICATION OF EXISTING ROOF CONSTRUCTION IS REQUIRED PRIOR TO THE INSTALLATION OF THE ROOF PLATFORM. ENGINEER OF RECORD IS TO APPROVE EXISTING CONDITIONS IN ORDER TO MOVE FORWARD.
- CENTERLINE OF PROPOSED STEEL PLATFORM SUPPORT COLUMNS TO BE CENTRALLY LOCATED OVER THE EXISTING BUILDING COLUMNS.
- EXISTING BRICK MASONRY COLUMNS/BEARING TO BE REPAIRED/REPLACED AT ALL PROPOSED PLATFORM SUPPORT POINTS. ENGINEER OF RECORD TO REVIEW AND APPROVE.

SPECIAL INSPECTION CHECKLIST		
BEFORE CONSTRUCTION		
CONSTRUCTION/INSTALLATION INSPECTIONS AND TESTING REQUIRED (COMPLETED BY ENGINEER OF RECORD)	REPORT ITEM	
REQUIRED	ENGINEER OF RECORD APPROVED SHOP DRAWINGS ¹	
REQUIRED	MATERIAL SPECIFICATIONS REPORT 2	
N/A	FABRICATOR NDE INSPECTION	
REQUIRED	PACKING SLIPS ³	
ADDITIONAL TESTING AND INSF	PECTIONS:	
DURING CONSTRUCTION		
CONSTRUCTION/INSTALLATION INSPECTIONS AND TESTING REQUIRED (COMPLETED BY ENGINEER OF RECORD)	REPORT ITEM	
REQUIRED	STEEL INSPECTIONS	
N/A	HIGH STRENGTH BOLT INSPECTIONS	
N/A	HIGH WIND ZONE INSPECTIONS 4	
N/A	FOUNDATION INSPECTIONS	
N/A	CONCRETE COMP. STRENGTH, SLUMP TESTS AND PLACEMENT	
N/A	POST INSTALLED ANCHOR VERIFICATION ⁵	
N/A	GROUT VERIFICATION	
N/A	CERTIFIED WELD INSPECTION	
N/A	EARTHWORK: LIFT AND DENSITY	
N/A	ON SITE COLD GALVANIZING VERIFICATION	
N/A	GUY WIRE TENSION REPORT	
ADDITIONAL TESTING AND INSP	PECTIONS:	
AFTER CONSTRUCTION		
CONSTRUCTION/INSTALLATION INSPECTIONS AND TESTING REQUIRED (COMPLETED BY ENGINEER OF RECORD)	REPORT ITEM	
REQUIRED	MODIFICATION INSPECTOR REDLINE OR RECORD DRAWINGS ⁶	
N/A	POST INSTALLED ANCHOR PULL-OUT TESTING	
REQUIRED	PHOTOGRAPHS	
ADDITIONAL TESTING AND INSPECTIONS:		

PROVIDED BY GENERAL CONTRACTOR; PROOF OF MATERIALS HIGH WIND ZONE INSPECTION CATB 120MPH OR CAT C,D FASTENING SCHEDULE

NEWPORT SOUTH RI

verizon

Design Group LLC

DANIFI P HAMM

REGISTERED

PROFÉSSIONAL ENGINEER

CONSTRUCTION DRAWNER OF RECORD'S STAMPE MONTHS AFTER ENGINEER OF RECORD'S STAMPE AND SIGNED SUBMITTAL DATE LISTED HEREIN

SUBMITTALS

5 02/08/21 REVISED PER COMMENTS

2 02/25/20 REVISED PER COMMENTS

1 01/31/20 REVISED PER COMMENTS

4 01/06/21 ADDED ELEVATIONS

11/09/20 MOVED RRH's

0 11/22/19 FOR CONSTRUCTION

DESCRIPTION

DPH


CHECKED BY:


APPROVED BY:

18 FLANDERS ROAD VESTROROLIGH, MA 01581


SITE ADDRESS: 16 OCHRE POINT AVENUE NEWPORT, RI 02840

SHEET TITLE STRUCTURAL NOTES SPECIAL INSPECTIONS

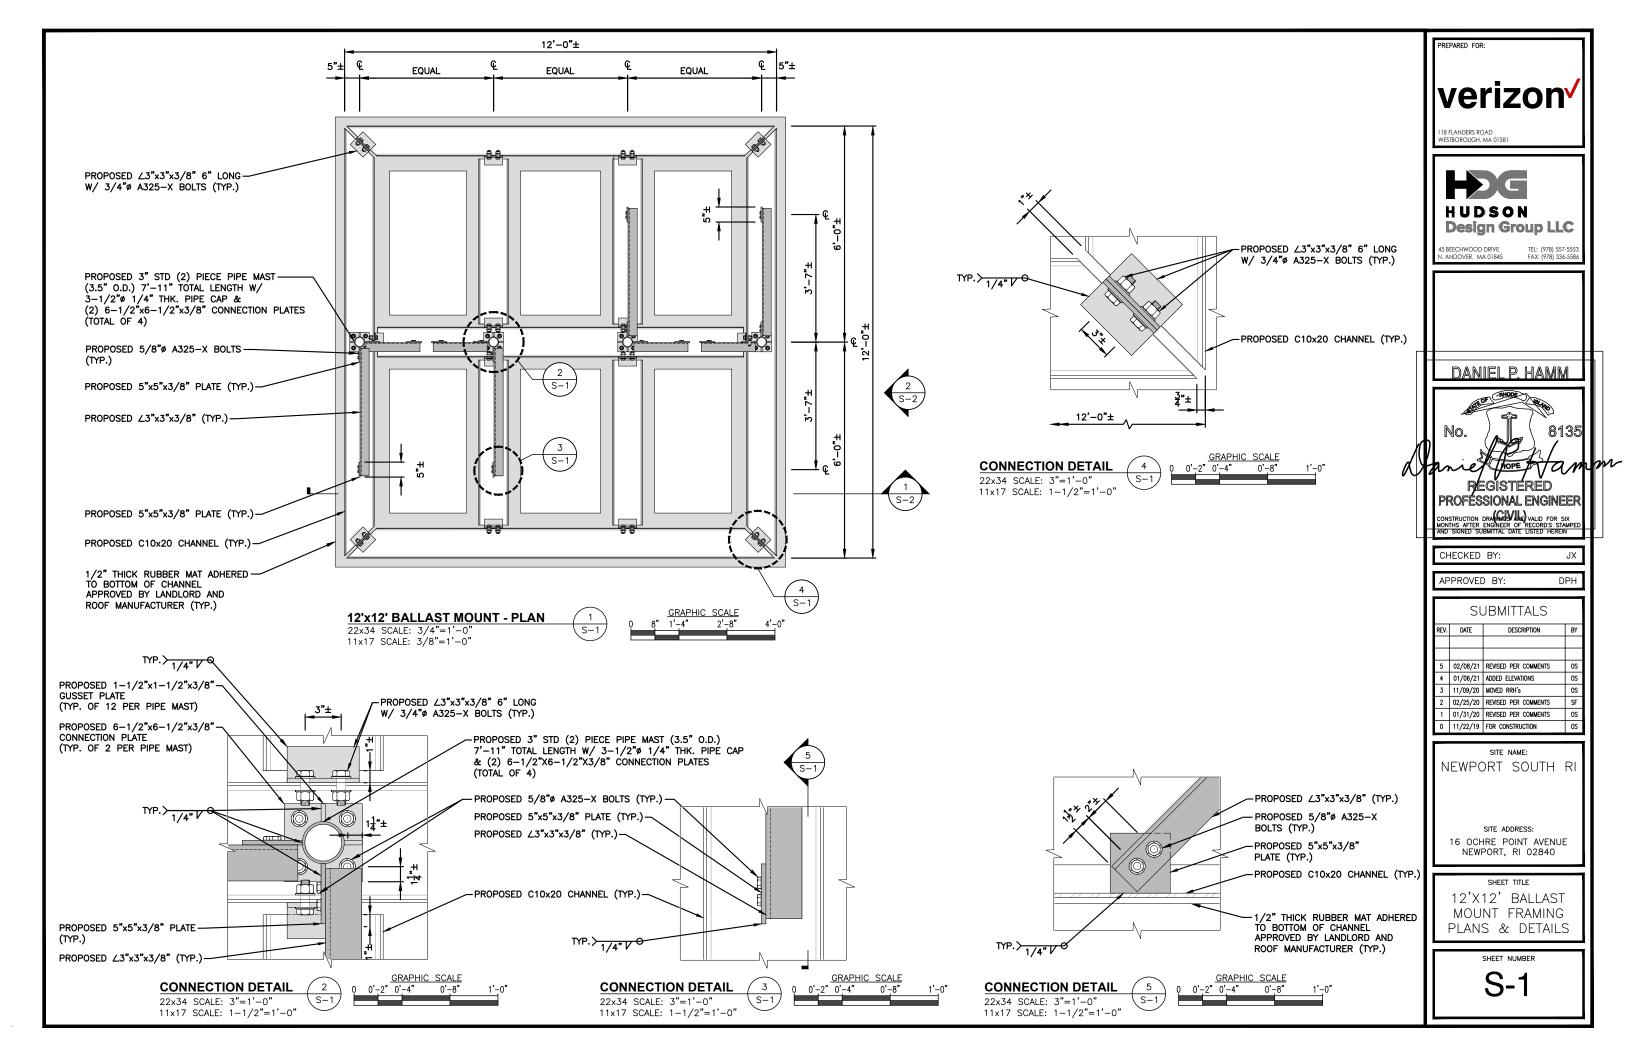

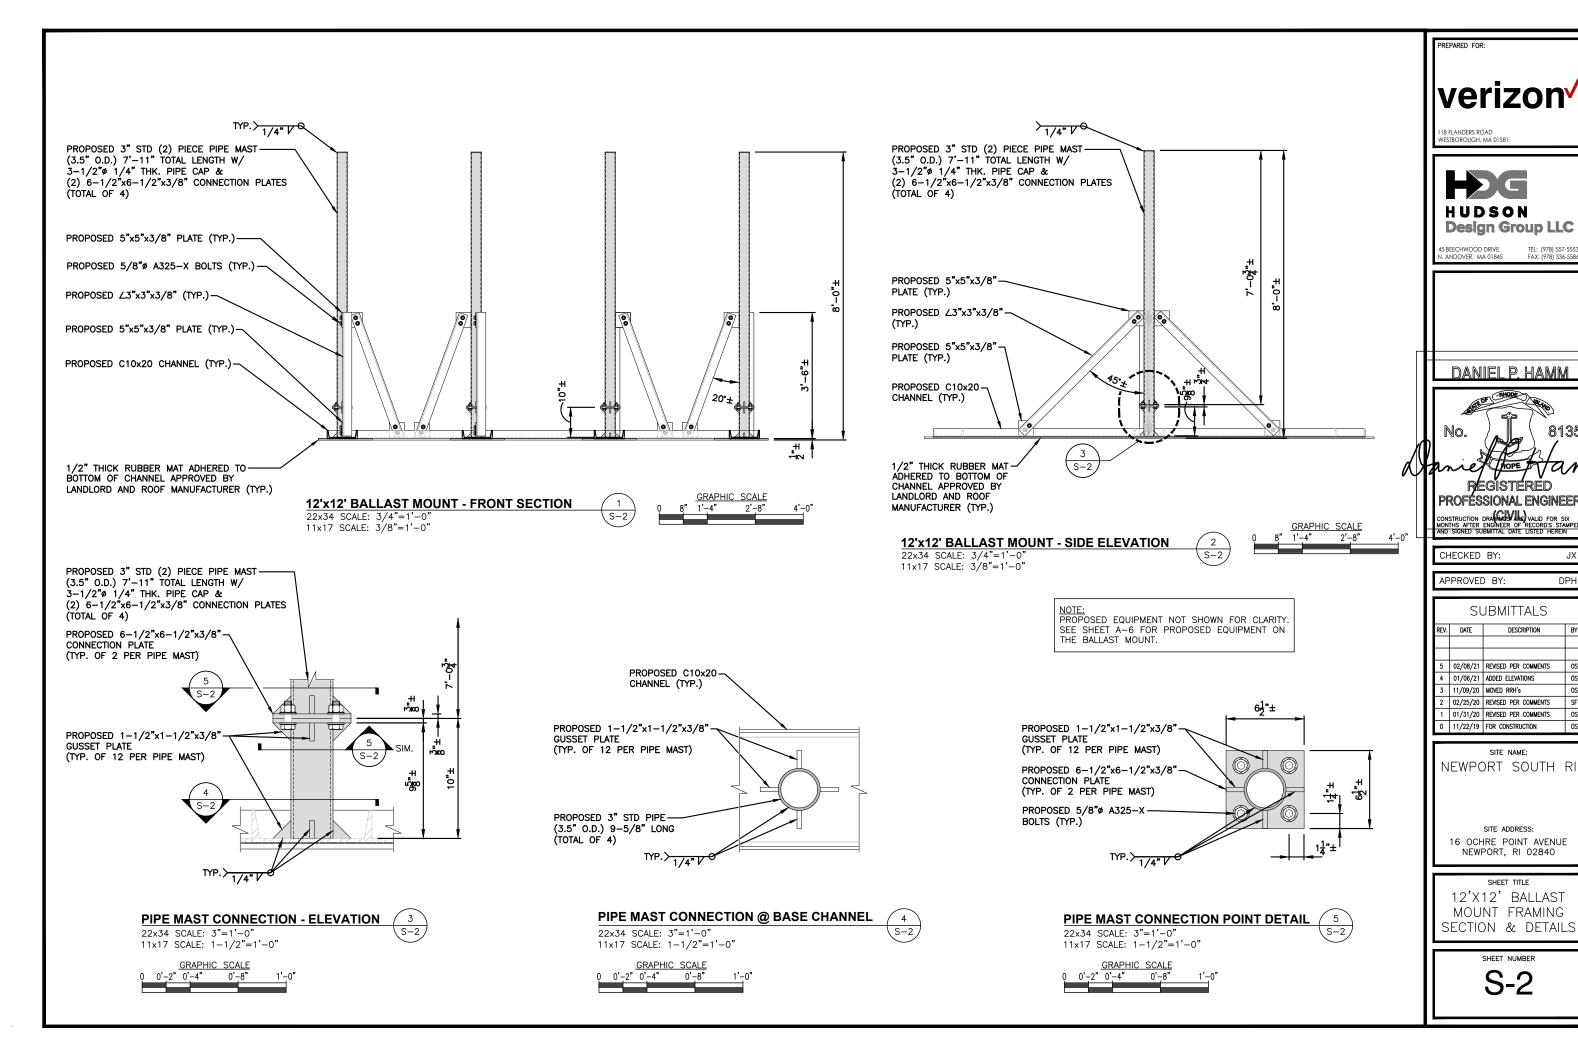

DPH

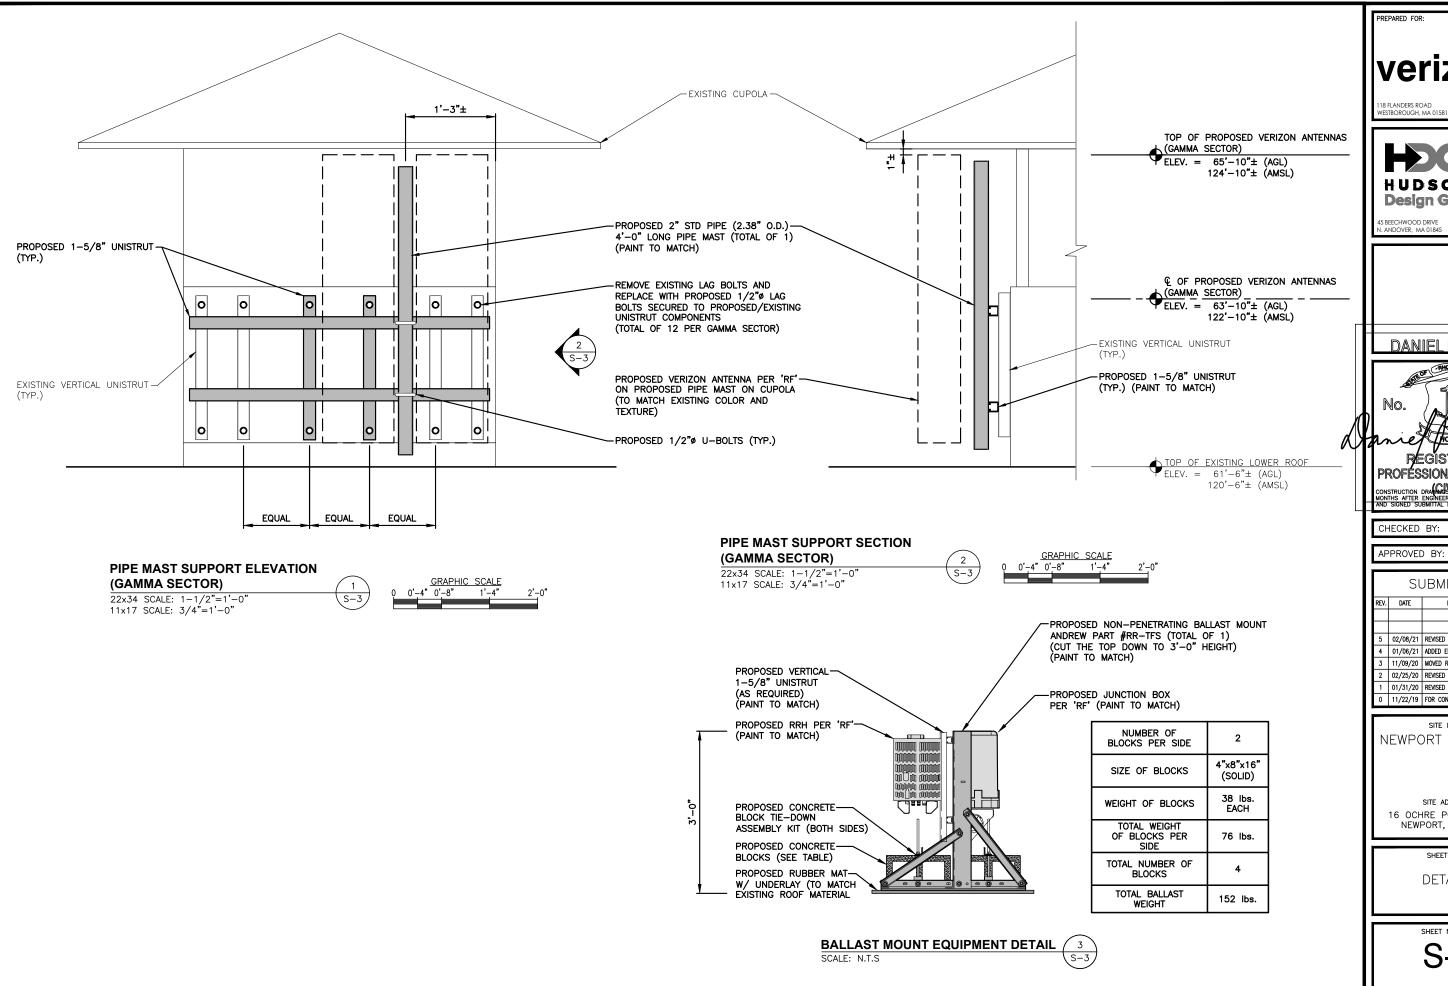

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HUDSON **Design Group LLC**

DANIEL P. HAMM



PROFÉSSIONAL ENGINEER

CHECKED BY:

APPROVED BY:

SUBMITTALS DESCRIPTION

DPH

5 02/08/21 REVISED PER COMMENTS 4 01/06/21 ADDED ELEVATIONS 3 11/09/20 MOVED RRH's 2 02/25/20 REVISED PER COMMENTS 1 01/31/20 REVISED PER COMMENTS 0 11/22/19 FOR CONSTRUCTION

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SHEET TITLE

DETAILS

SHEET NUMBER